CONSTRUCT

DEVELOPMENT APPLICATION

21 VEGA ST, REVESBY LOT 46 IN DP 1528 CANTERBURY-BANKSTOWN COUNCIL

CHANGE OF USE FROM A SINGLE STOREY HOUSE TO A COMMUNITY FACILITY

PROJECT NO.

24-021

ISSUED FOR DA

AERIAL VIEW LOCATION MAP





PROPOSED OUTDOOR COVERED AREA



REVESBY

DEVELOPMENT DATA

LOT SIZE: xxx.xxm²

COUNCIL COMPLIANCE	ALLOWED	PROVIDED	COMPLY
MIN FRONTAGE	N/A	N/A	N/A
MAX SITE COVERAGE	N/A	N/A	N/A
FLOOR SPACE RATIO	N/A	0.28:1	YES
MAX BUILDING HEIGHT	9.0m	7.7m	N/A
FRONT SETBACK	N/A	N/A	N/A
SIDE SETBACK 1	0.9m for awning	0.9m for awning	YES
SIDE SETBACK 2	0.9m for awning	8.3m for awning	YES
REAR SETBACK	N/A	N/A	N/A
CORNER SETBACK	N/A	N/A	N/A
LANDSCAPE AREA	N/A	N/A	N/A
PRIVATE OPEN SPACE	N/A	N/A	N/A

SITE CALCULATION

EXISTING DWELLING, GARAGE & SECONDARY DWELLING

238.57m²

SHEET SCHEDULE

A000	TITLE PAGE
A001	COVER PAGE
A002	SPECIFICATION PAGE
A003	SITE PLAN & ANALYSIS
A004	GROUND FLOOR PLAN EXISTING
A005	ROOF PLAN
A006	DEMOLITION PLAN
A007	GROUND FLOOR PLAN - PROPOSED
800A	GROUND FLOOR PLAN - DETAIL
A009	ELEVATIONS
A010	SECTIONS
A011	CONCEPT LANDSCAPE PLAN
A012	AREA PLAN
A013	PLAN OF MANAGEMENT OPTION 1
A014	PLAN OF MANAGEMENT OPTION 2
A015	3D VIEWS
A016	MATERIAS & FINISHES
A017	EROSION & SEDIMENT CONTROL PLAN
NNA3	NEIGHBOUR NOTIFICATION
NNA4	NEIGHBOUR NOTIFICATION A4

STANDARD SPECIFICATION

BE ADVISED: SOME CLAUSES IN THIS SPECIFICATION MAY NOT BE RELEVANT TO THIS PROJECT

1.0 GENERAL

- 1.1 ALL DIMENSIONS SHALL BE CHECKED ON SITE PRIOR TO COMMENCEMENT ANY WORK.
- ALL MATERIALS SHALL COMPLY WITH RELEVENT CURRENT AUSTRLIAN
 STANDARDS AND SHALL BE NEW AND THE BEST OF THEIR RESPECTIVE KINDS
 AND SUITABLE FOR THEIR INTENDED PURPOSES.
- 1.3 ALL WORKMANSHIP SHALL COMPLY WITH RELEVENT CURRENT AUSTRALIAN
 STANDARDS AND TO GOOD TRADE PRACTICES.
- STANDARDS AND TO GOOD TRADE PRACTICES.

 1.4 ALL WORK SHALL BE IN ACCORDANCE WITH REQUIREMENTS OF THE
- RESPECTIVE AUTHORITY HAVING JURISDICTION OVER THE WORKS.
- 1.5 THE ARCHITECTURAL DRAWINGS SHOULD BE READ IN CONJUNCTION WITH

 THE SPECIFICATION, SCHEDULES AND CONSULTANTS DRAWINGS THAT FORMS
- PART OF THE CONSTRUCTION DOCUMENTS REFERRED TO IN THE "BUILDING CONTRACT."
- 1.6 DO NOT SCALE FROM DRAWINGS. NOTIFY OF ANY ERRORS OR OMISSIONS
- BEFORE PROCEEDING WITH ANY WORKS.
- 1.7 ENSURE THAT BACKGROUNDS ARE SUITABLE FOR THE INTENDED

 SUBSEQUENT FINISHES. COMMENCEMENT OF WORK ON THE BACKGROUNDS
 - IMPLIES ACCEPTANCE BY THE SUBCONTRACTOR OF THE BACKGROUNDS ON WHICH FINISHES ARE APPLIED.
- 1.8 SUPPLY ALL EQUIPMENT NECESSARY FOR THE COMPLETION OF RESPECTIVE WORKS.
- 1.9 PROGRESSIVELY CLEAN UP AFTER THE COMPLETION OF RESPECTIVE WORKS.

2.0 EARTHWORKS

- 2.1 UNLESS OTHERWISE STATED, REMOVE TOPSOIL TO A MINIMUM DEPTH OF 200mm INCLUDING ALL ROOTS, AND OTHER MATTER, AND REQUIRED BY THE SOIL CONDITION AND/OR THE BUILDER. PROVIDE SUITABLE CLEAN FILLING
- SAND AND COMPACT IN LAYERS NOT GREATER THAN 300mm TO REDUCE LEVELS AS SHOWN.
 2.2 COMPACT SAND FILLING AND SANDY SUB GRADES UNDER FOOTINGS AND
- SLAB TO OBTAIN MIN. SEVEN (7) BLOWS PER 300mm ON A STANDARDS PERTH
- SAND PENEFROMETER TEST (AS PER AS 1289 F3.3)
- 2.3 DO NOT EXCAVATE SERVICES TRENCHES WITHIN AN ANGEL OF 45 DEGREES DOWN FROM BOTTOM EDGE OF FOOTING.
- 2.4 ALL RETAINING WALLS TO BE TREATED WITH "BITKOTE" WATERPROOFING AGENT.

3.0 CONCRETE

- 3.1 CONCRETE REINFORCEMENT AND FORMWORK SHALL BE TO A STRUTURAL
- ENGINEERS DETAILS, RELEVANT BUILDING CODES AND STANDARDS
- 3.2 ALL CONCRETE TO CONFORM TO THE REQUIREMENTS OF AS 3600 CONCRETE STRENGTH GRADE: N20, AGGREGATE 20mm, SLUMP 80mm.
- 3.3 SLAB IS TO BE CURED FOR 7 DAYS MIN. & SLAB REINFORCEMENT PLACED ON APPROVED CHAIRS TO
- 3.4 THE FOOTING AND SLAB CONSTRUCTION IS TO COMPLY WITH AS 2870.
- 3.5 PROVIDE A PROPRIETARY VAPOR BARRIER WHICH CONSISTS OF HIGH IMPACT
- RESISTANT POLYTHENE FILM MIN. 0.2mm THICK WHICH HAS BEEN PIGMENTED AND BRANDED BY
- 3.6 TERMITE PROTECTION:
 - PROVIDE ANTI-TERMITE TREATMENT UNDER THE BUILDING AREAS IN
 - ACCORDANCE WITH AS 2057, AS 3660.1 AND APPENDIX D, FOR RETICULATED SYSTEMS.
 - BUILDER SHALL PROVIDE "DURSBAN" (HAND SPRAYED ORGANO-PHOSPHATE)
 - STANDARD CODES.

4.0 BRICKWORK

- 4.1 BRICK WORK SHALL COMPLY WITH
 - AS 3700 MASONRY CODE
 - AS A123 MASONRY CODE
- MORTAR FOR MASONRY CONSRUCTION
- 4.2 BRICK GAUGE 7 STANDARD COURSES = 600mm.

 4.3 ALL BRICKS SHOULD HAVE MIN. COMPRESSIVE STRENGTH OF 20MPA
- AND AS FOLLOWS:
- EXTERNAL FACE WORK: 230x110x76mm

 EXTERNAL PENIDED: 205x162x90mm MAXIBRICK OR VER
- WINDOW SILLS: 2c FACE BRICK SPLAYED SILLS
- WINDOW HEADS: SOLID FACEBRICK COURSE
- INTERNAL WALLS: 305x162x90mm MAXIBRICK OR VERTICORE
 WITH BED JOINT AND PERPENDS FILLED
 - 305x76x90mm LONGREACH OR JUMBO FOR
 - COURSE ADJUSTMENT
- 4.4 MORTAR: 1:1:6 CEMENT:LIME:SAND
- MORTAR (FACE BRICK) COLOR TO MATCH EXISTING AS SELECTED
 TIES SHALL BE 3.5mm DIAMETER GALVANIZED WIRE KINKED FOR AND BUILT IN
- EVERY 5TH COURSE AT APPROXIMATELY 900mm CENTRES, WITH ADDITIONAL TIES AT THE RATE OF 1 TIE/300mm HEIGHT OF OPENINGS AND VERTICAL
 - CONTROL JOINTS AND WITHIN 150mm OF THE OPENINGS. BUILD TIES INTO
 - EACH LEAF AT LEAST 50mm. VERTICAL CONTROL JOINTS SHALL BE 12mm WIDE
 - $\label{filled at completion with 'compriband' continuous filler strip. \\$

- 4.6 KEEP CAVITIES CLEAR OF MORTAR. PROVIDE CAVITY BOARDS. TEMPORARILY
 OMIT BRICKS TO PERMIT RAKING OUT OF CAVITY BOTTOMS.
- 4.7 FORM WEEP HOLES EVERY FOURTH PERPEND ABOVE FLASHINGS AND CAVITY
 FILL KEEP CLEAR OF MORTAR. DO NOT LOCATE WEEPHOLES CLOSER THAN
- 4.8 PROVIDE DAMP PROOF COURSES (DPC) IN THE BOTTOM 3 COURSES OF
 BRICK WORK AND SLAB AND/OR FOOTINGS. DPC ADDITIVE SHALL BE CLEAR IN
- 4.9 SETOUT BRICKWORK ACCURATELY, PLUMB, LEVEL AND PROPERLY BONDED.
 RISING WORK TO BE RAKED BACK, JAMBS, REVEALS, CORNERS, PERPENDS,
 ETC. TO BE TRUE, PLUMB, AND IN LINE WITH PERPENDS TRUE TO LINE.
 SETOUT DOOR FRAMES NEAR PERPANDICULAR WALL WITH A MARGIN OF
- 12mm OR GREATER THAN 50mm.

 4 10 MOISTEN ALL EXTRUDED BRICKS BEFORE LAYING.

ALL FACEWORK

- 11 PROVIDED 12mm PLASTERING MARGIN BETWEEN WINDOW FRAME AND INTERNAL BRICKWORK TO BE PLASTERED.
- 4.12 WHERE NECESSARY REINFORCE BELOW AND OVER OPENINGS WITH
 GALVANISED WOVEN WIRE FABBIC 75mm WIDE IN CENTRE OF EACH LEAF
 LOCATED IN 2 COUSES BELOW SILL AND IN THE 2 COURSES ABOVE AN
- 4.13 BUILD IN ALCOR/PGI FLASHINGS AS FOLLOWS:
 - -WHEREVER SHOWN ON DRAWINGS.
 - -CAVITY WALLS BUILT OF SLAB ON GROUND (WHERE NOT PARGED.)
 -OVER LINTELS TO EXPOSED OPENINGS:
 - FULL WIDTH OF OUTER LEAF CONTINUOUS ACROSS CAVITY 50mm INTO
 - INNER LEAF 2c ABOVE.
 - -OVER ROOF
- FULL WIDTH OF EXTERAL LEAF, STEPPED TO ROOF SLOPE TURNED DOWN MIN.
 50mm OVER BASE FLASHING. TURN UP IN CAVITY SLOPING INWARDS AND BUILT
- INTO INNER LEAF 1c ABOVE.
 - FULL HIGHT 150mm WIDE FIXED TO FRAMES INTERLEAVED WITH SILL AND HEAD FLASHING AT EACH END.
- -STRUCTURE OR SERVICES WITHIN 30mm OF OUTER BRICK LEAF IN CAVITY:
- VERTICAL FLASHINGS CONTINUOUS 1c BELOW FLTO ABOVE STRUCTURE OR
- FRAME. NOMINAL 300mm WIDE. FOR HORIZONTAL STRUCTURES / SERVICES:
 CONTINUOUS FLASHING BUILT IN AS FOR OVER LINTELS.
- -AT CAVITY WALLS WITH GLASS BLOCK 300mm WIDE FIXED TO GLASS BLOCK FRAME
- AND TURNED AWAY IN CAVITY FROM INNER LEAVE.

4.14 LINTELS

MAX SPAN	LINTELS SIZE	BEARING	
(mm)	(VERT x HORIZ x THICK)	EACH END (mm)	
900	75×10	150	
1200	75x75x8	150	
1500	90x90x8	150	
1800	100x75x8	230	
2100	125x75x8	230	
2400	125x75x10	230	
2500	100×100×8	230	
3000	150x90x10	230	

5.0 CARPENTRY WORK

- ROOF AND CEILING FRAMING SHOULD COMPLY WITH AS 1684 LIGHT TIMBER FRAMING
 CODE. DRAW STRAP FIRMLY OVER WALL PLATES AND SECURELY FIX TO TOP OF PLATE
 BY 2x30mm GALV. CLOUTS/STRAP.
- 5.2 REFER TO AS 1684 FOR ROOF FRAMING SIZES UNLESS SPECIFIED ON DRAWINGS.
- SUPPLY AND FIX ALL BULKHEADS & FALSE CEILINGS AS SHOWN ON THE DRAWINGS.

6.0 METALWORK

- ELECTRIC AND GAS METER BOXES AS SHOWN IN DRAWINGS
- WINDOW FRAMES SHALL BE RESIDENTIAL OR COMMERCIAL SECTION WITH POWDERCOAT FINISH AS SELECTED BY OWNER. ALLOW FOR RLYSCREENS TO ALL WINDOWS. REFER TO ADDENDUM. ANGLED WINDOW UNITS SHALL BE FACTORY MADE AND REVED AND DETURERED ON SITE AS COMPLETE LIMIT.
- 6.3 CLOTHES HOIST: REFER TO ADDENDUM.

7.0 ROOFING

- .1 SELECTED ROOFING MATERIAL SHALL BE INSTALLED AND FIXED IN ACCORDANCE WITH MANUFACTURERS SPECIFICATION AND RELEVANT BUILDING CODES
- 7.2 GUTTER, FASCIA, DOWN PIPES, FLASHINGS SHALL BE IN LONGEST POSSIBLE LENGTHS AND SHALL MATCH EXISTING

- 7.3 DOWN PIPES SHALL MATCH EXISTING.
- 7.4 ALLOW FOR ALL JOINTS AND JOINING MATERIALS, COLLARS, STRAPS & FASTENINGS NECESSARY TO COMPLETE WORK.
- 7.5 ALLOW FOR ALL ROOF PENETRATIONS, ROOF COWLS, FLASHINGS, FLUMES THROUGH ROOF.
- 7.6 FIX GUTTERS & FLASHINGS TO PERMIT THERMAL MOVEMENT IN THEIR FULL LENGTH
- 7.7 SEAL BETWEEN OVERLAPPING FLASHINGS; FLASHINGS TURNED DOWN OVER BASE OR APRON FLASHINGS; FLASHINGS OVER METAL ROOF; FLASHINGS OVER SECRET GUTTERS; AROUND ROOF PENETRATIONS ETC.

8.0 JOINERY

- 8.1 ALL JOINERY SHALL BE OF HIGHEST QUALITY MATERIALS TO BEST TRADE PRACTICES
 AND HIGH QUALITY FINISH.
- 8.2 EXTERNAL DOOR FRAMES SHALL BE: 110x40 DOUBLE REBATED FRAME WITH 130x40
 WEATHERED THRESHOLD LIN O
- 8.3 SUPPLY AND BUILD IN TIMBER DOOR FRAMES TO EXTERNAL LOCATIONS AS SHOWN ON ARCHITECTURAL DRAWINGS.

9.0 CEILINGS

- 9.1 CEILINGS SHALL BE RECESSED EDGE, MINIMUM 8.0mm PLASTERGLASS OR GYPROCK.
- 9.2 FLUSH JOINTS, SCREW HEADS, AND OTHER BLEMISHES IN THE SHEETS USING
- 9.3 PROVIDE AND FIX ALL FLUSH STOP BEADS & CASING BEADS TO ALL CORNERS & EDGES.
- .4 PROVIDE ALL SELECTED MOLDINGS AND CORNICES TO ALL CEILINGS AS STATED IN ARCHITECTURAL DOCUMENTS.

10.0 PLASTERING

- 10.1 INTERNAL WALL FINISHES INCLUDING CUPBOARD, BIN, & FRIDGE RECESSES, ETC.

 SHALL BE (OTHER THAN FACE FINISHES OR WHERE COVERED BY FEATURE MATERIALS
- 10.2 PLASTERED WALLS SHALL BE NOMINAL 12mm THICK CONSISTING OF 1:1:9,
- CEMENT: LIME: SAND RENDER, AND FINISHED WITH NOMINALLY 3mm HARDWALL PLASTER

 10.3. SUPPLY AND FIX EXTERNAL CORNER BEADS TO ALL EXTERNAL CORNERS.
- 10.4 PROVIDE STOP BEADS WHERE PLASTER WORK ABUTS TIMBER FRAMES, OR FACEWORK
- 10.5 EXTERNAL RENDER WHEN APPLICABLE SHALL BE 2 COAT SAND FINISH. (FOR PAINTING)
- 10.6 NIBS IN INTERNAL CORNERS ADJACENT TO DOOR FRAMES GREATER THAN 40mm SHA NOT BE FLUSHED UP WITH FRAMES.
- 10.7 PROVIDE V-JOINTS IN RENDER & FINISHING PLASTER WHERE BRICK WORK ABUTS OR

11.0 GLAZING

- 1.1 CLEAR GLASS GENERALLY: OBSCURE GLASS TO BATHROOMS, REFER TO DRAWINGS ALL TO THE RELEVANT AUSTRALIAN STANDARDS.
- .2 WHERE GLASS BLOCKS HAVE BEEN NOMINATED, THEY SHALL BE IN FRAMES AND INSTALLED TO MANUFACTURES SPECIFICATIONS.

12.0 FLOORING FINISHES


- 2.1 CARPET FLOOR COVERINGS TO NOMINATED AREAS COMPLETE WITH SELECTED UNDERLAY SMOOTH EDGE, DIMINISHING STRIPS ETC, TO COMPLETE THE WORKS: REFER TO DRAWINGS & FINISHES SCHEDULE.
- 2 PROVIDE TILED FLOOR FINISHES TO NOMINATED AREAS COMPLETE WITH ALL MATERIALS ANGLE TRIMS, ETC.TO COMPLETE THE WORKS:
- 12.3 PROVIDE TIMBER FLOOR FINISHES TO NOMINATED AREAS COMPLETE WITH ALL MATERIALS, DIMINISHING BOARDS ETC. TO COMPLETE THE WORKS: FLOOR BOARDS TO BE SANDED & POLISHED TO HIGH STANDARD WITH PREMIUM QUALITY SEALER (2 COATS).


13.0 SIGNAGE

- 13.1 WHERE NECESSARY SUPPLY & FIX SELECTED UNIT AND HOUSE NUMBERS TO EACH UNIT
 AND TO LETTERBOXES AS SCHEDULED.
- 3.2 "SUPERDRAFT" RESERVES THE RIGHT TO ERECT A BUILDERS SIGN ON THE PROPERTY FACING THE STREET FRONTAGE IN COMPLIANCE WITH AUTHORITY REQUIREMENTS.

14.0 PAVING

- 14.1 GENERALLY: WHEN PAVING IS INCLUDED IN THE BUILDING CONTRACT, THE FOLLOWING
 SHALL APPLY AS A MINIMUM STANDARD
- 14.2 SUPPLY AND LAY ALL PAVING TO EXTERNAL AREAS AS SHOWN ON WORKING DRAWING
- CUT, FILL AND COMPACT SAND TO REQUIRED LEVELS. SCREED TO UNIFORM THINNESS
 AND LEVELS
 PROVIDE BRICK EDGE-RETRAINING FOOTING EMBEDDED IN MORTAR BENEATH THE
- 1.4 PROVIDE BRICK EDGE-RETRAINING FOOTING EMBEDDED IN MORTAR BENEATH THE PAVING BRICK, GENERALLY. TO DRIVEWAY AREAS, PROVIDE NOMINAL 300x150mm CONCRETE FOOTING ALONG PERIMETER OF DRIVEWAY AND BED EDGE BRICK IN MORTAR
- 14.5 PROVIDE 100mm COMPACTED LIMESTONE BASE TO DRIVEWAY TOPPED WITH 50mm CLEA
- 14.6 PAVING PATTERN: REFER TO ADDENDUM.
- BRICK PAVERS SHALL BE:
- TRAFFICABLE AREAS: MIN. 65mm SOLID CLAY OR CONCRETE

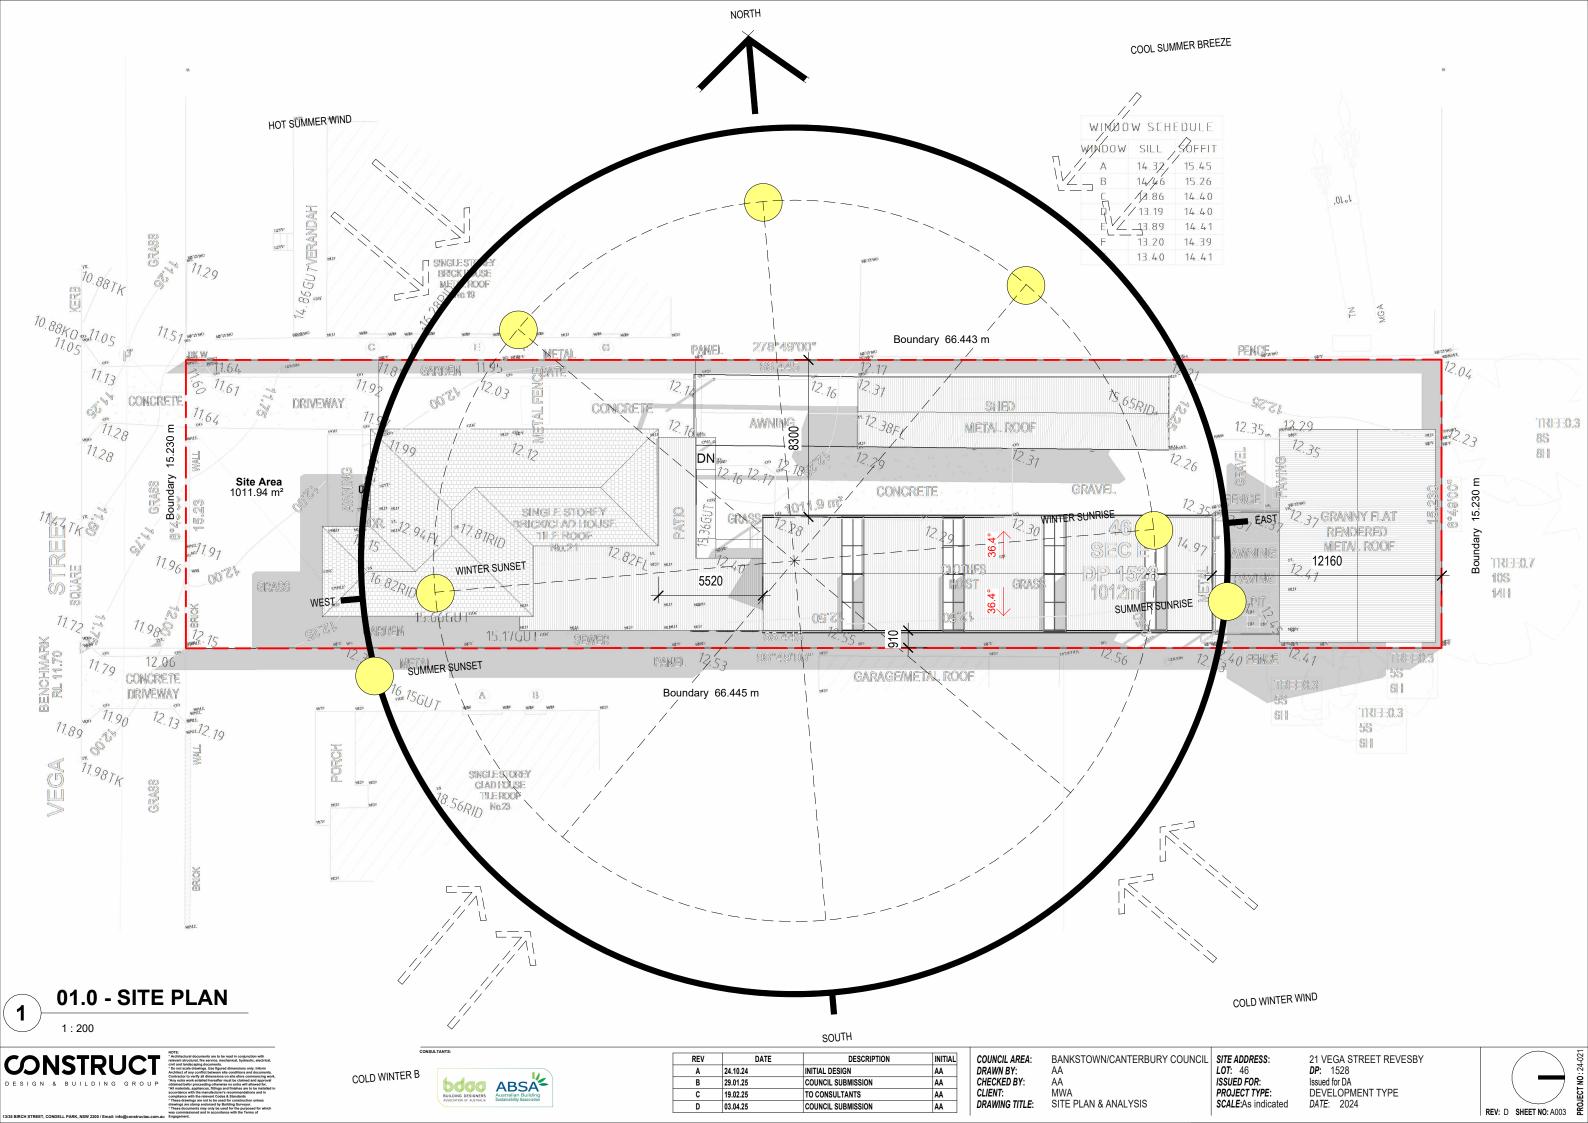

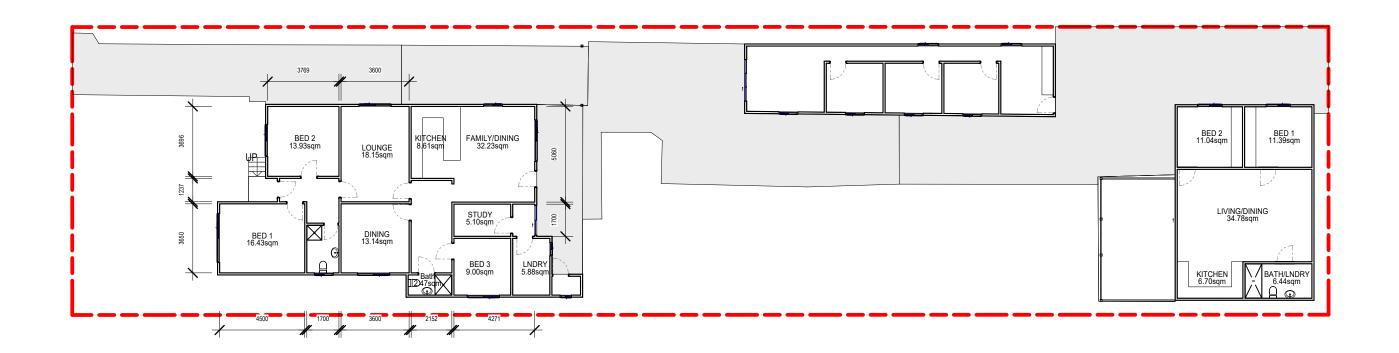

GENERAL NOTES:		WALL LEGEND:
ALL LEVELS, CONTOURS AND RL'S, ARE TO AUSTRALIAN HEIGHT DATUM (AHD) AND ARE IN METRES U.N.O.	ALL DRAWINGS AND DOCUMENTATION TO BE READ IN CONJUNCTION WITH SPECIALIST CONSUTLANT REPORTS AND ENGINEERS DETAILS WHERE APPLICABLE	NOTE: ANY LOAD BEARING WALL CONSTRCUTION TO ENGINEER'S DETAILS, FINISHES AS PER ELEVATIONS AND FINISHES SCHEDULE
DIMENSIONS ARE IN MILLIMETRES U.N.O.	FLOOR STRUCTURE TO WET AREAS TO BE SETDOWN 50mm	90mm TIMBER STUD
FIGURED DIMENSIONS TO BE TAKEN IN PREFERENCE TO SCALE	TO ALLOW FOR TILE/FINISH/FALL AND FINISH FLUSH WITH ADJOINING FLOOR FINISHES	240mm BRICK VERNEER
SITE CONFIRMATION SHOWN ON THIS DRAWING HAS BEEN	SMOKE DETECTORS TO BE INSTALLED IN ACCORDANCE WITH AS3786	240mm BRICK VERNEER + 30-50mm STONE/TILE FACING
SUPPLIED BY OTHERS. NO RESPONSIBILITY IS TAKEN FOR ITS AUTHENTICITY OR ACCURACY. THE BUILDER SHALL VERIFY	ALL EXTERNAL FITTINGS. WHERE STAINLESS STEEL MUST	230mm BRICK
THE LOCATION OF ALL SERVICES, VEGETATION AND DIMENSIONS PRIOR TO COMMENCMENT. ANY DISCREPANCIES	BE 316 MARINE GRADE WITH PROTECTIVE ANTI CORROSIVE COATING	280mm DOUBLE BRICK
SHOULD BE REPORTED TO ARCHITECTS & DESIGNERS.	ALL STONE (CLADDING, FACING, BLOCKWORK) TO BE	110mm SINGLE BRICK
ALL WORK TO BE CONSTRUCTED IN ACCORDANCE WITH THE BUILDING CODE OF AUSTRLAIA AND ALL RELEVANT AUSTRALIAN STANDARDS AND STATUTORY REQUIREMENTS	SEALED WITH INIMUM THREE COATS OF 'DRY TREAT STAIN PROOF - IN ACCORDANCE WITH MANUFACTURER'S SPECS, PROVIDE 15 YEAR WARRANTY FROM MANUFACTURER'S	190mm MASONRY BLOCK

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GROUND FLOOR PLAN EXISTING


CONSTRUCT




REV	DATE	DESCRIPTION	INITIAL
Α	24.10.24	INITIAL DESIGN	AA
В	29.01.25	COUNCIL SUBMISSION	AA
С	19.02.25	TO CONSULTANTS	AA
D	03.04.25	COUNCIL SUBMISSION	AA

COUNCIL AREA: BANKSTOWN/CANTERBURY COUNCIL SITE ADDRESS: LOT: 46
CHECKED BY: AA
CLIENT: MWA
DRAWING TITLE: GROUND FLOOR PLAN EXISTING

SITE ADDRESS:
LOT: 46
ISSUED FOR:
PROJECT TYPE:
SCALE: 1: 200

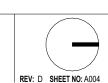

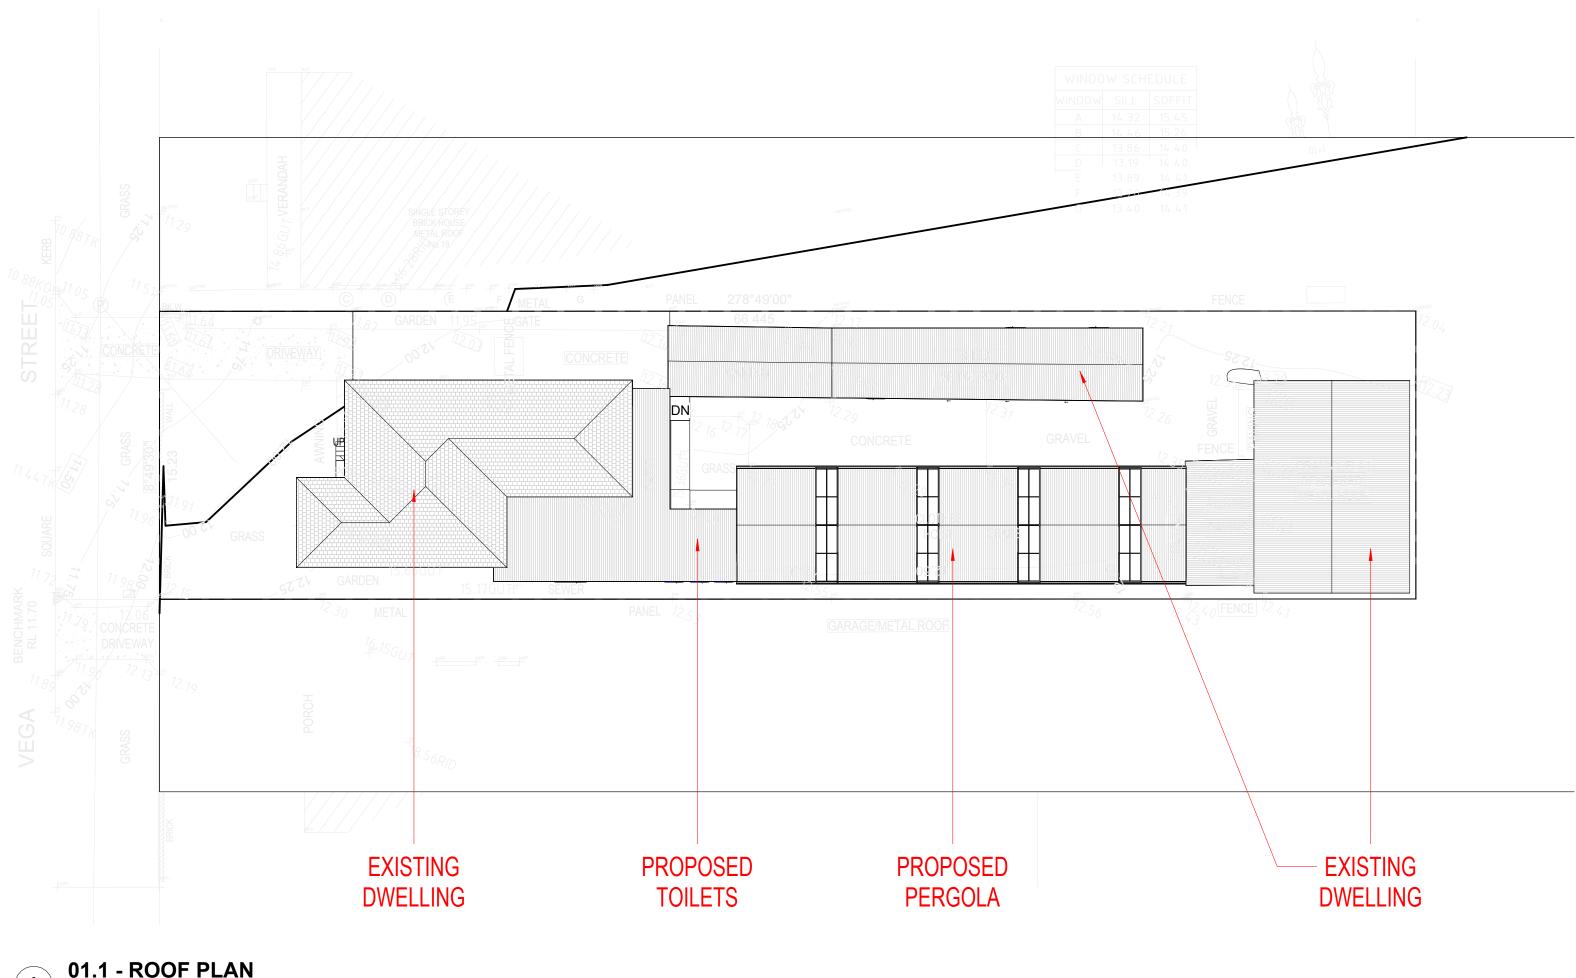




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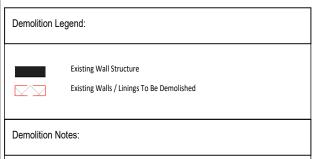


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COUNCIL AREA: BANKSTOWN/CANTERBURY COUNCIL DRAWN BY: AA
CHECKED BY: AA
CLIENT: MWA
DRAWING TITLE: ROOF PLAN

SITE ADDRESS:
LOT: 46
ISSUED FOR:
PROJECT TYPE:
SCALE: 1: 200



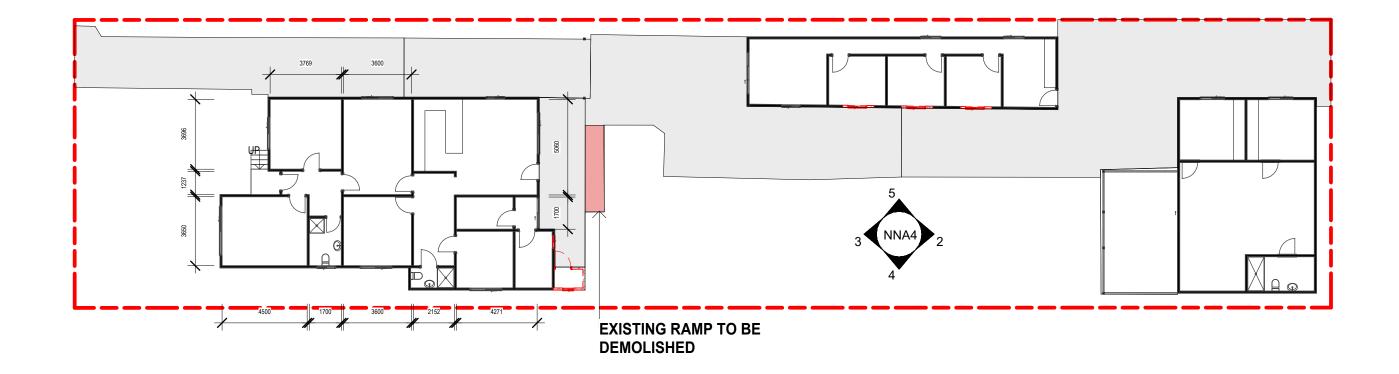

- * All Demolition Work To Comply To AS 2601
- All Demonstration Work To Collippy To A3 Door State State State To Ensure Removal And Disposal Of All Existing Asbestos Linings To Be In Accordance With Contamination Report And Local Authorities Guidlines
- * Builder To Confirm All Existing Wall Construction Build-ups When Retained
 * Builder To Maintain Sedimentation Control Measures In Accordance With Council Requirements
- * Builder To Cap Off Plumbing & Electrical, And Relocate Pipework/Conduits To Suit New Works
 Where Required For Reused Service Points

GROUND FLOOR PLAN EXISTING

1:200







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D	03.04.25	COUNCIL SUBMISSION	AA

BANKSTOWN/CANTERBURY COUNCIL ADDRESS: LOT: 46 DRAWN BY: CHECKED BY: AA
CLIENT: MWA
DRAWING TITLE: DEMOLITION PLAN CHECKED BY:

ISSUED FOR:
PROJECT TYPE:
SCALE:As indicated

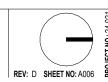

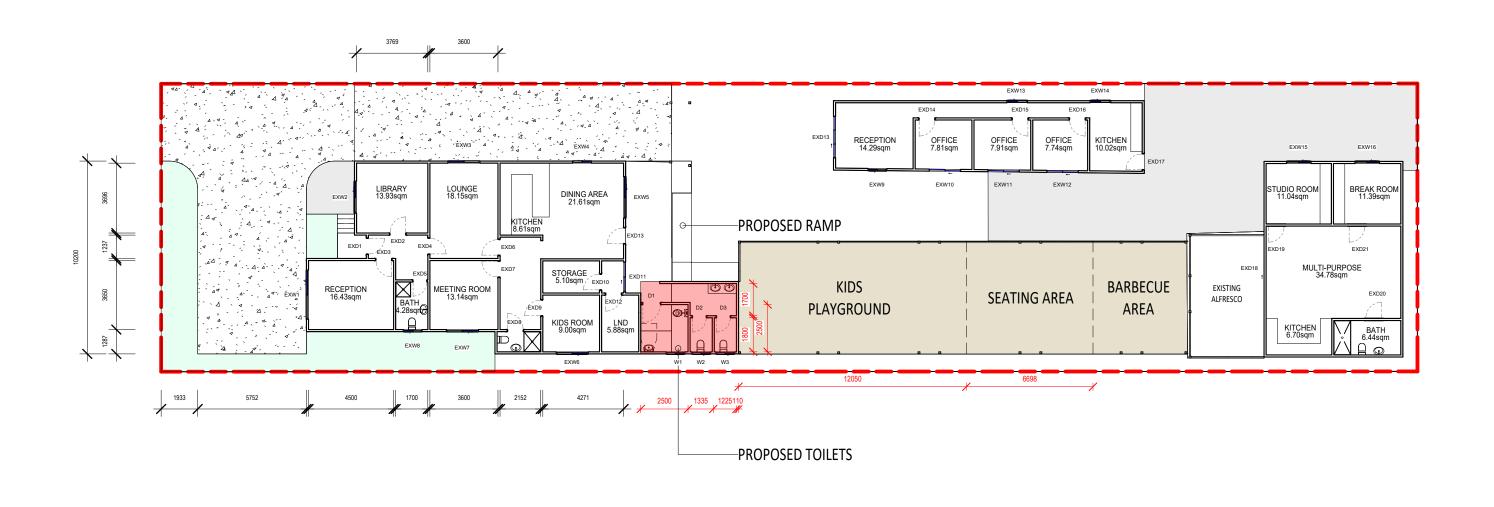









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D	03.04.25	COUNCIL SUBMISSION	AA

DRAWN BY: CHECKED BY:

BANKSTOWN/CANTERBURY COUNCIL AA SITE ADDRESS: LOT: 46 AA MWA GROUND FLOOR PLAN -PROPOSED


21 VEGA STREET REVESBY DP: 1528 Issued for DA DEVELOPMENT TYPE DATE: 2024 ISSUED FOR: PROJECT TYPE: SCALE: 1:200

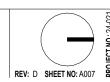

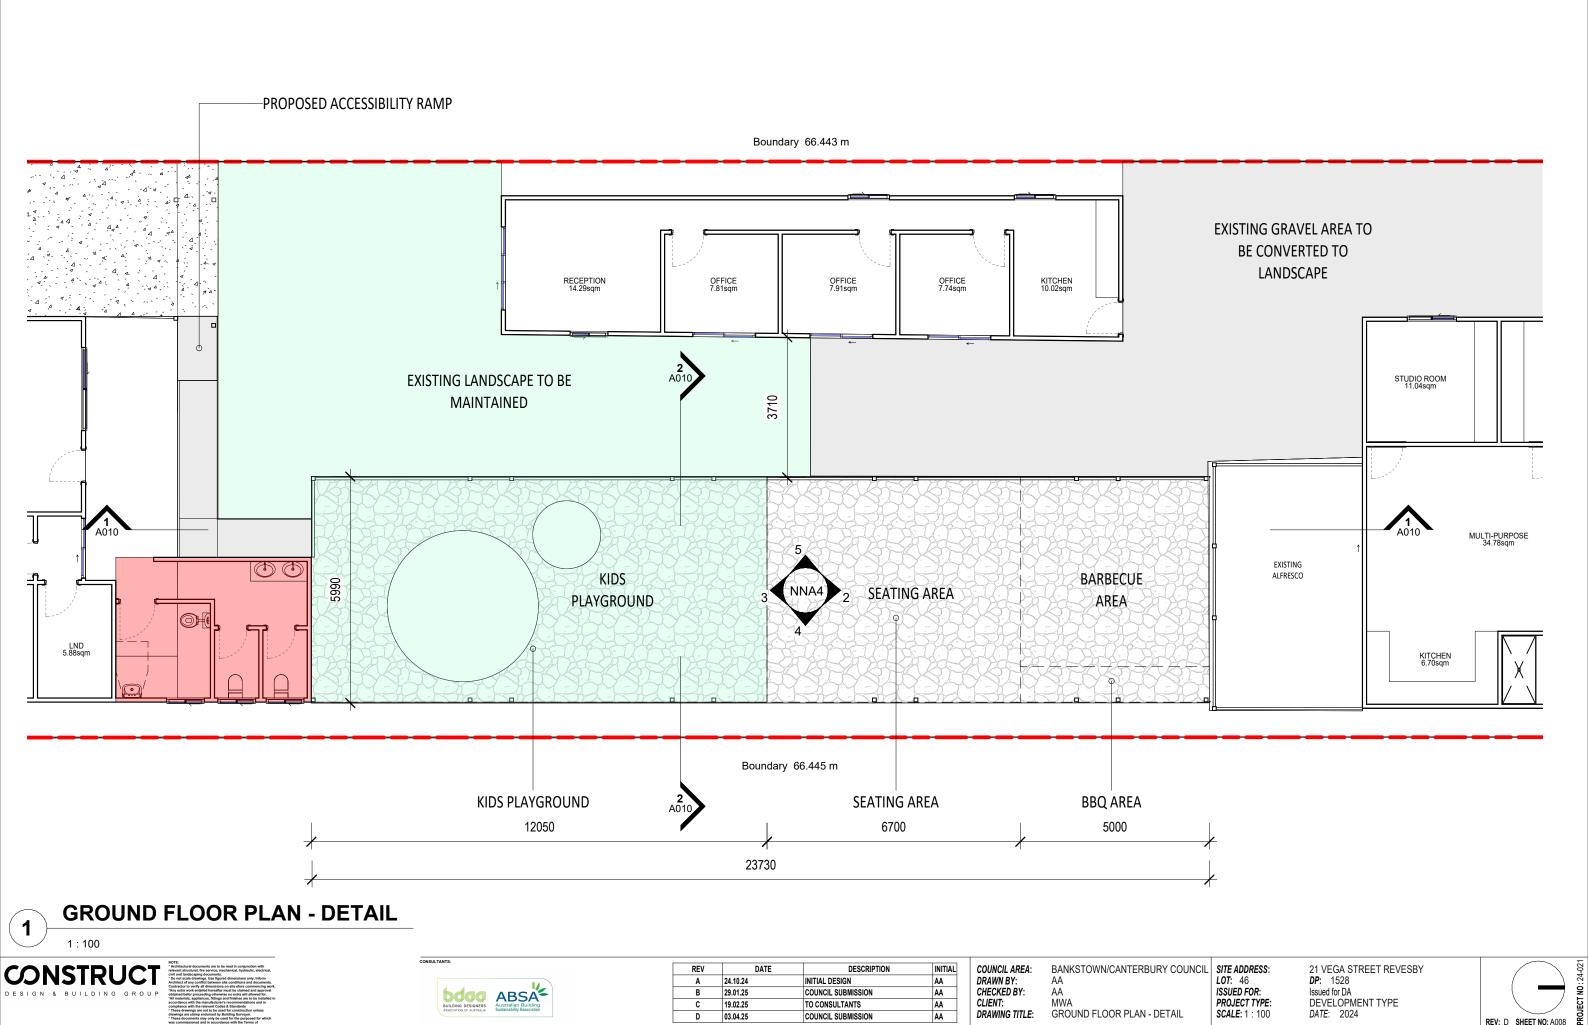


03.04.25


COUNCIL SUBMISSION

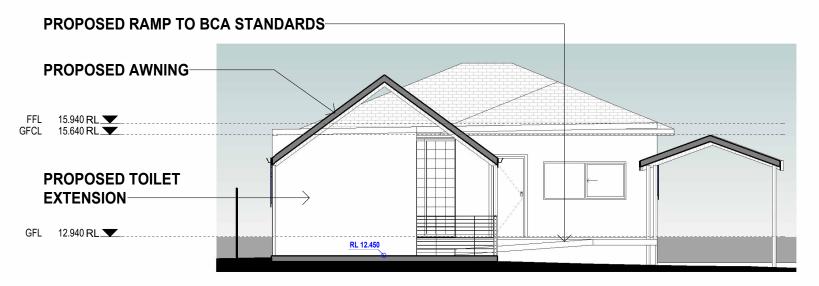

EXISTING HOUSE & PROPOSED ACCESSIBILTY RAMP

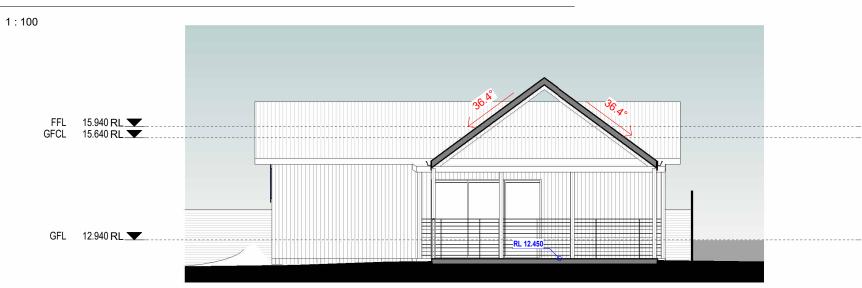

EXISTING GRANNY FLAT & PROPOSED BBQ AREA

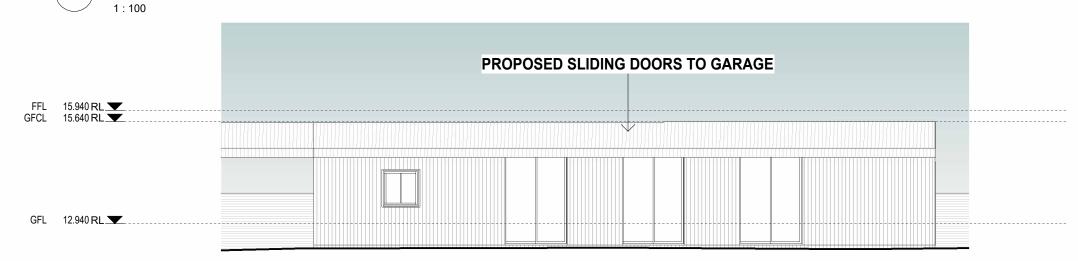

EXISTING GARAGE 3 1:100







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COUNCIL AREA: BANKSTOWN/CANTERBURY COUNCIL SITE ADDRESS: DRAWN BY: CHECKED BY: CLIENT: MWA
DRAWING TITLE: ELEVATIONS


ISSUED FOR: PROJECT TYPE: SCALE: 1: 100



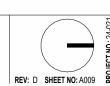

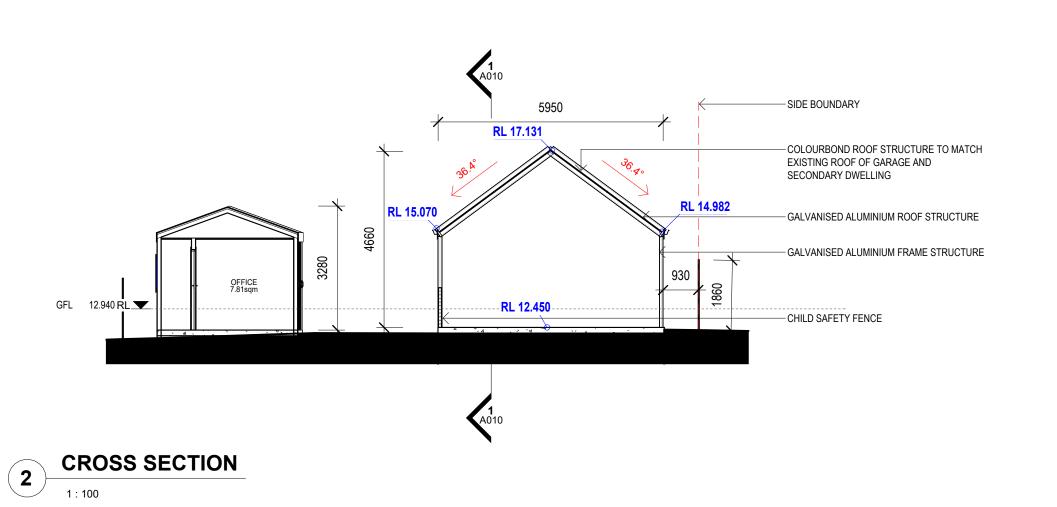DOOR SCHEDULE NEW							
Mark		Location	Frame Type	Height	Width	Finish	Frame Material
137	GFL			2100	820		
D1	GFL			2100	920		
D2	GFL			2100	720		
D3	GFL			2100	720		
EXW10	GFL			2426	1664		
EXW11	GFL			2426	1664		
EXW12	GFL			2426	1664		

WINDOW SCHEDULE NEW							
Mark	Location	Window Style	Height	Width	Material	Glazing	
180			1000	700			
182			600	600			
186			1000	1000			
187			1000	1000			
190			1000	1000			
EXW1			1000	2600			
EXW2			1000	1700			
EXW3			1000	1700			
EXW4			1000	1000			
EXW5			1000	2200			
EXW6			1000	1700			
EXW7			1000	1700			
EXW8			600	1000			
EXW9			1000	1000			
EXW13			1000	1100			
EXW14			1000	1100			
EXW15			1000	1300			
EXW16			1000	1300			
W1			600	1000			
W2			600	1000			
W3			600	1000			

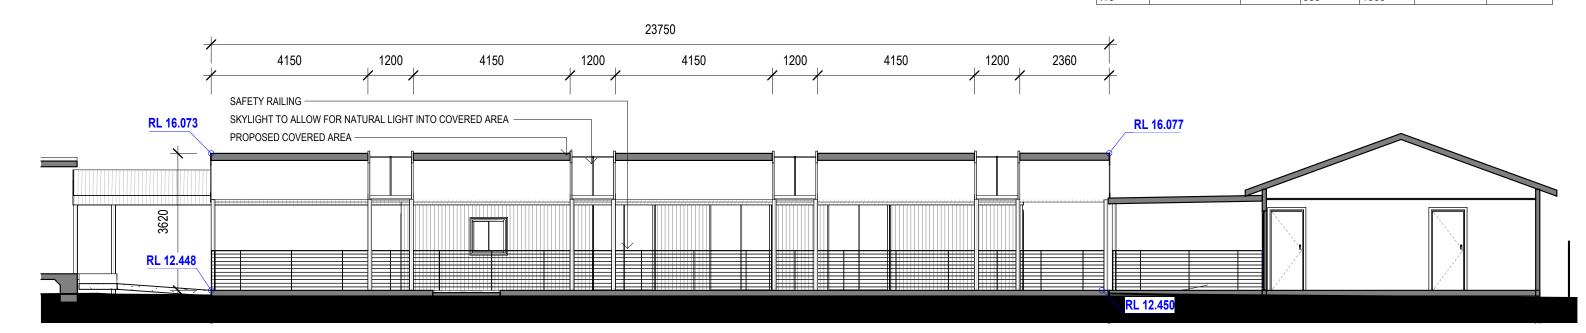

LONG SECTION OF PLAY, SEATING AND BBQ AREA

1:100

CONSTRUCT





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В	29.01.25	COUNCIL SUBMISSION	AA
С	19.02.25	TO CONSULTANTS	AA
D	03.04.25	COUNCIL SUBMISSION	AA

COUNCIL AREA: DRAWN BY: CHECKED BY:

BANKSTOWN/CANTERBURY COUNCIL | SITE ADDRESS:

21 VEGA STREET REVESBY **DP**: 1528 LOT: 46 ISSUED FOR: PROJECT TYPE: SCALE: 1:100 Issued for DA
DEVELOPMENT TYPE
DATE: 2024

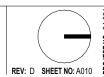

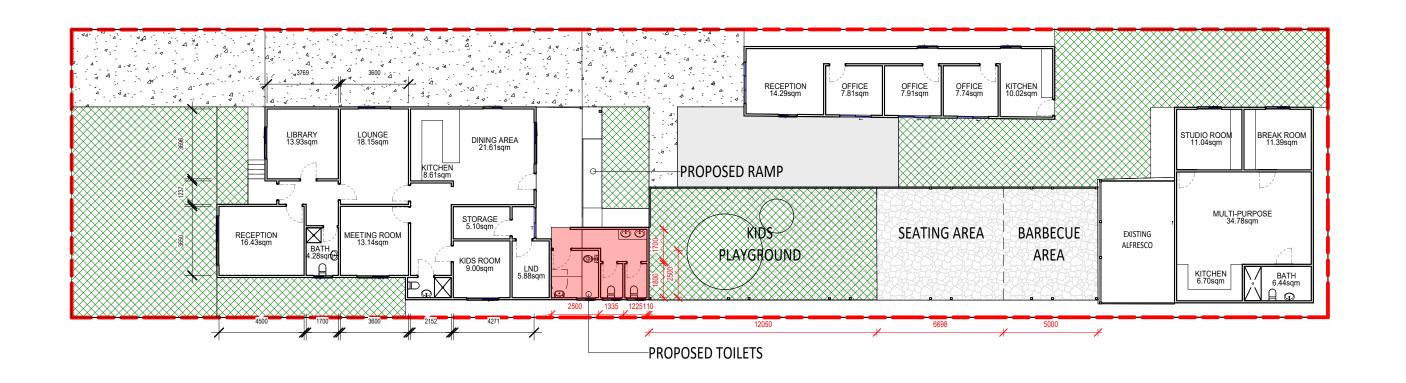



CONCEPT LANDSCAPE PLAN

	Landscaping Notes:						
	Turfed Area * All newly turfed areas to be selected weed free pennistum clandestium. Turf shall be laid neatly butted with staggered joints flush with adjacent	Botanic Name	Common Name	Quantity	Staking	Size	Legend
Garden Areas * All garden areas are to be filled with	surfaces and have even running falls to all drainage points. Garden Areas * All garden areas are to be filled with 250mm depth of weed free top quality garden soil which has been treated with spent mushroom compost.	Trees EF - Eucalyptus Fibrosa	Broad Lead Ironbark	1	Yes	75L	EF /
	* Proivde a minimum 75mm depth of pine bark flakes or selected leaf mulch to all garden beds. * All new tress shall be double stalked using underwood stakes (1800mm x 25 x 25mm) and double tied with hessain webbing.	PC - Pyrus Calleryana	Callery Pear	1	Yes	35L	PC
	* Prior to the commencent of any site works, all existing trees to be retained shall be enclosedwith protective fencing to prevent them being damaged during the construction period. * All finished levels are to be verified by the builder on site.	Shrubs Gs - Grevillea Sericea	Pink Spider Flower	31	-	5L	(Gs)
	* All landscaping work to be in strict accordance to councils/privated certifiers code and guidlines. *This drawing is to be read in conjuction with all submitted architectural. * Hydraulics and engineering drawings where applicable.	Nr - Native Rosemary Aussie Box	Westringia hybrida Aussie Box	Planter	-	15L	

Landscape Calculations:				hardwood stakes
Individual Site Area	1012sqm		2	hessain webbing
Proposed Dwelling	291sqm			mulch
Front Landscape Grass	94sqm	EF	GS	cultivated subgrade garden so
Front Landscape Hard	31sqm			Tree Planting Detail
Rear Landscape Grass	153sqm			Selected non-extruded brick laid in mortar bed
Total Landscape	247sqm	第二 二十		soil underlay
Total Landscape %	25%			garden soil brick laid 10mm mortar joint
P.O.S.	141sqm	PC	Nr	for sharp curves, cut, bri to allow 10mm joint Brick Edging Detail







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COUNCIL AREA: BANKSTOWN/CANTERBURY CO DRAWN BY: AA CHECKED BY: MN CLIENT: MWA DRAWING TITLE: CONCEPT LANDSCAPE PLAN BANKSTOWN/CANTERBURY COUNCIL SITE ADDRESS:

21 VEGA STREET REVESBY DP: 1528 Issued for DA DEVELOPMENT TYPE DATE: 2024 LOT: 46
ISSUED FOR:
PROJECT TYPE:
SCALE:As indicated



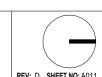

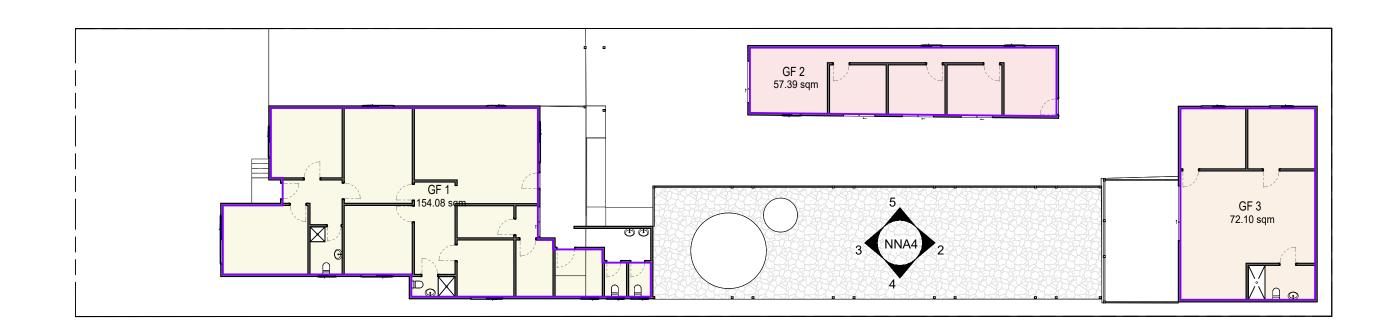Area S	Schedule
Name	Area

GF 1	154 m²
GF 2	57 m²
GF 3	72 m²
SITE AREA	1012 m²
MAXIMUM GFA	405 m ²
TOTAL GFA	284 m²








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CHECKED BY: AA
CLIENT: MWA
DRAWING TITLE: AREA PLAN

SITE ADDRESS:
LOT: 46
ISSUED FOR:
PROJECT TYPE:
SCALE: 1: 200



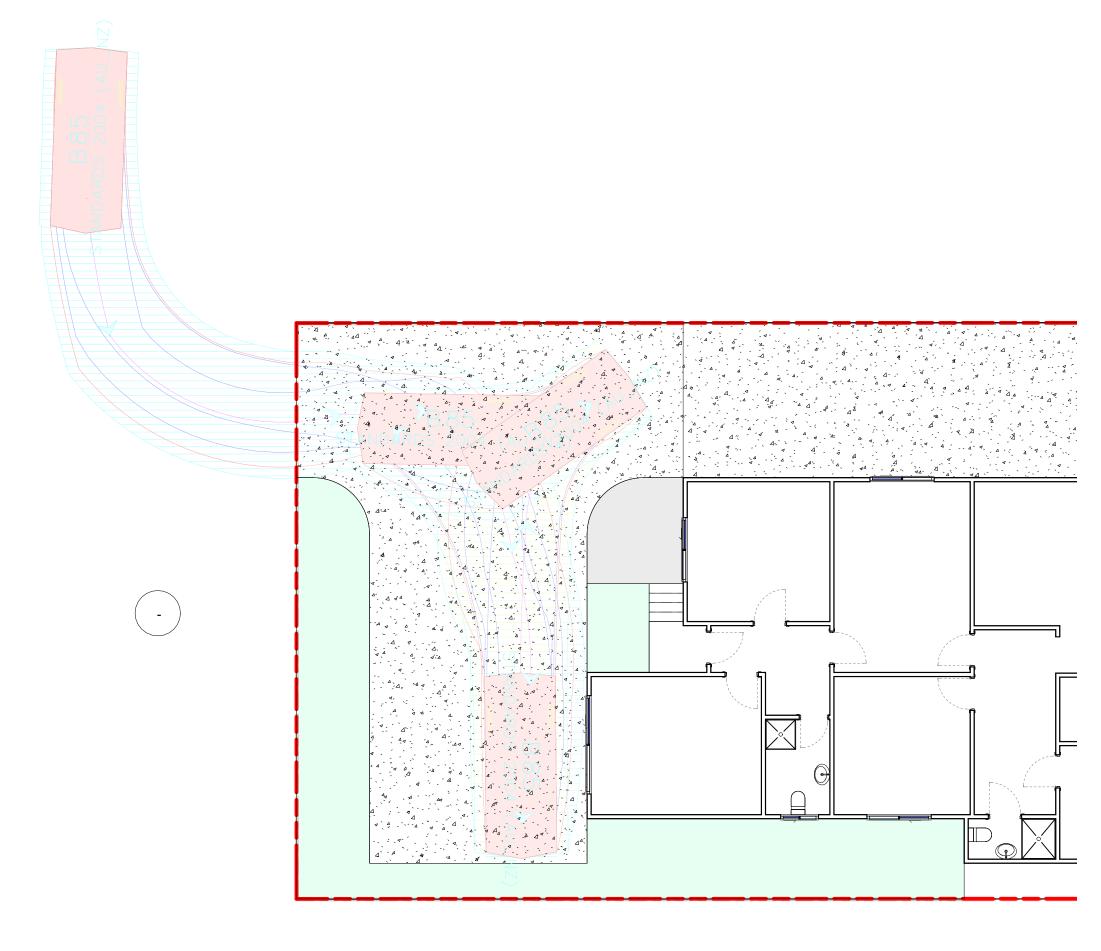


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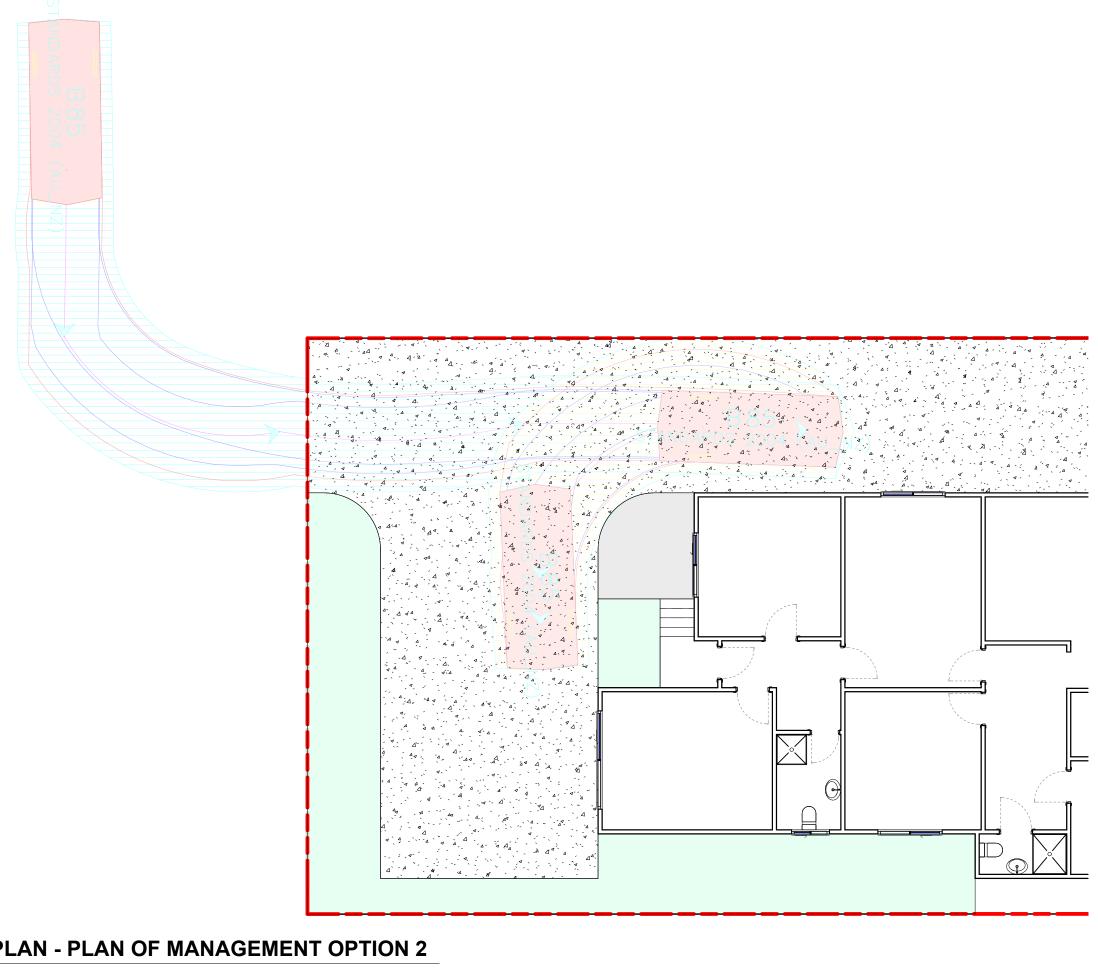


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CHECKED BY: AA
CLIENT: MWA
DRAWING TITLE: PLAN OF MANAGEMENT OPTION

SITE ADDRESS:
LOT: 46
ISSUED FOR:
PROJECT TYPE:
SCALE: 1: 100





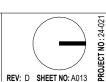


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CHECKED BY: AA
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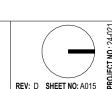




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CHECKED BY: AA
CLIENT: MWA
DRAWING TITLE: 3D VIEWS

SITE ADDRESS:
LOT: 46
ISSUED FOR:
PROJECT TYPE:
SCALE:

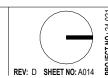



















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DODO	ABSA
BUILDING DESIGNERS ASSOCIATION OF AUSTRALIA	Australian Building Sustainability Association


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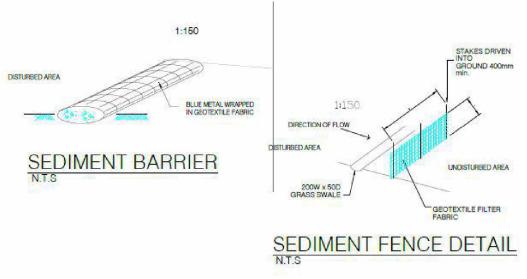
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CHECKED BY: AA
CLIENT: MWA
DRAWING TITLE: MATERIAS & FINISHES


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LOT: 46
ISSUED FOR:
PROJECT TYPE:
SCALE:



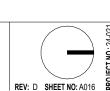

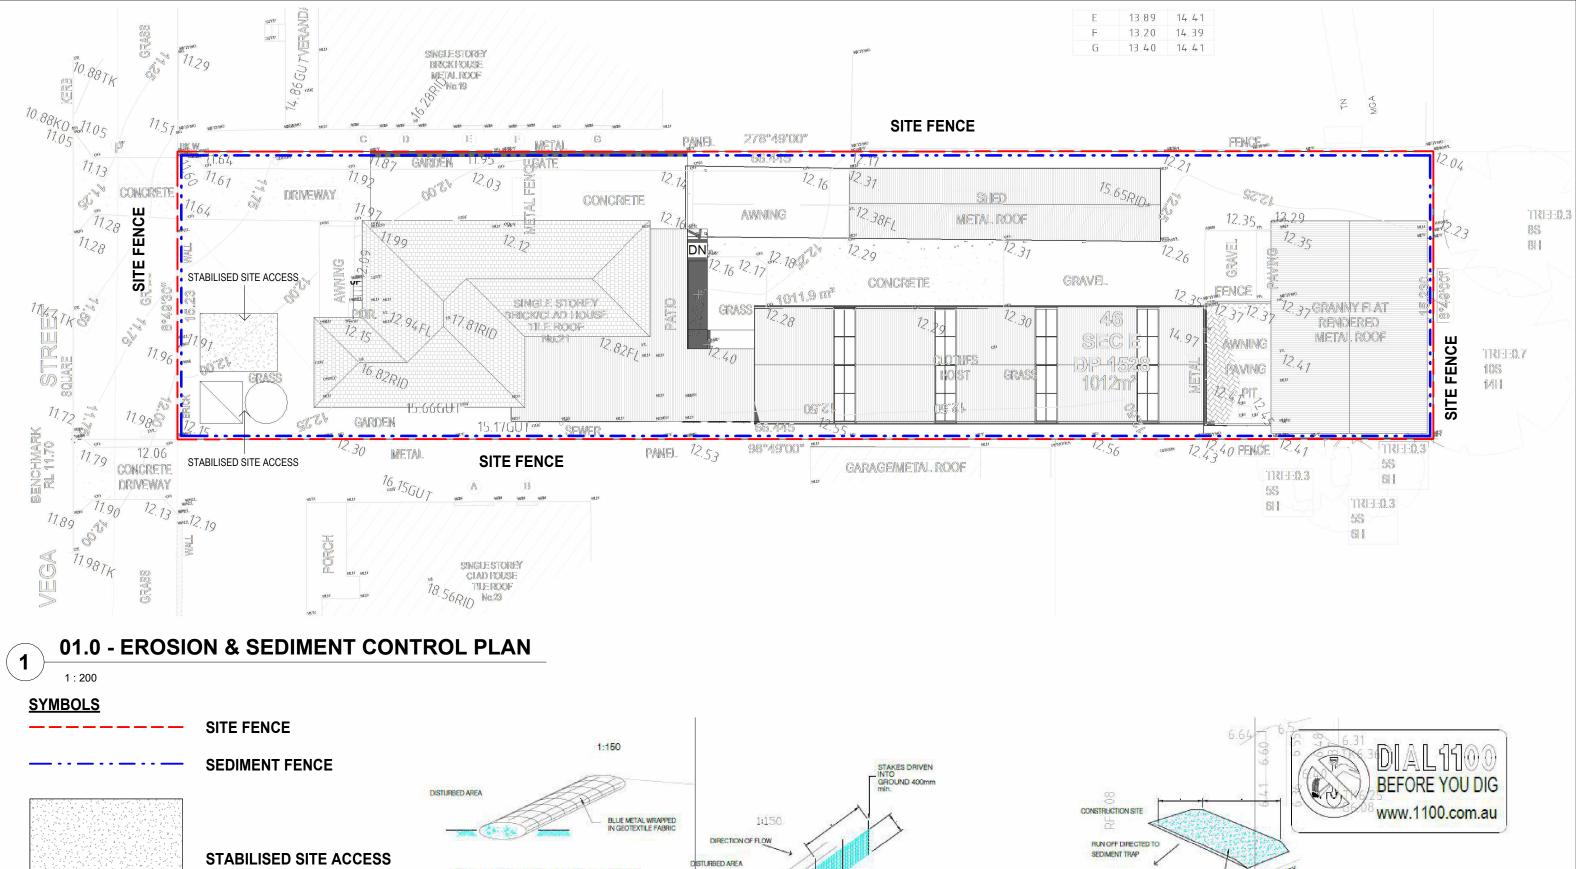

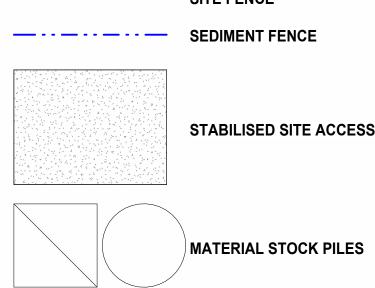

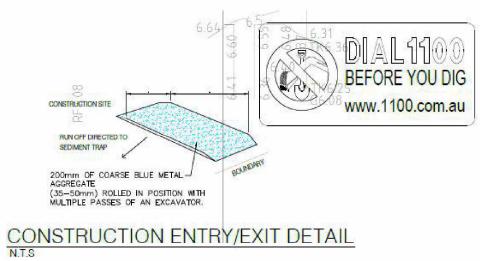






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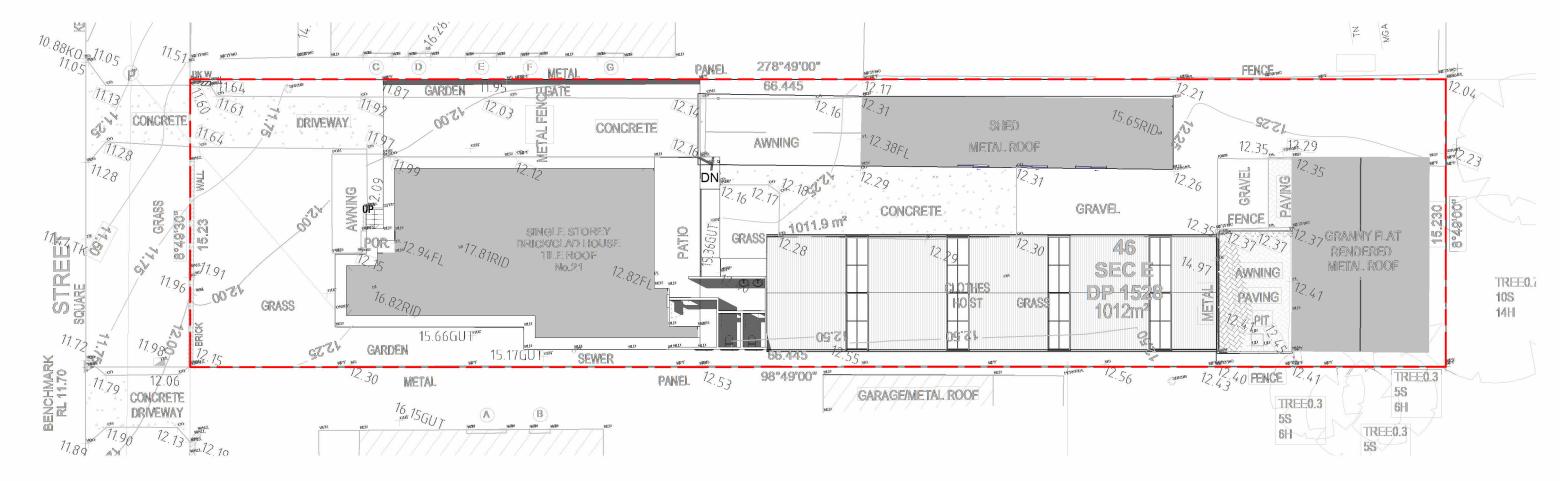
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CONTROL PLAN


BANKSTOWN/CANTERBURY COUNCIL | SITE ADDRESS: **EROSION & SEDIMENT**

21 VEGA STREET REVESBY **DP**: 1528 ISSUED FOR: Issued for DA PROJECT TYPE: DEVELOPMENT TYPE DATE: 2024 SCALE:As indicated



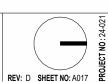

NN - NEIGHBOUR NOTIFICATION A3 1

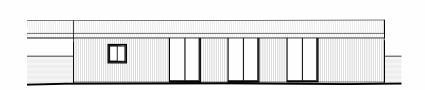

NN - PROPOSED OUTDOOR AREA

5

1:200

NN - EXISTING GARAGE 2 1:200



NN - EXISTING HOUSE & PROPOSED ACCESSIBILTY RAMP

NN - EXISTING GRANNY FLAT & PROPOSED BBQ AREA 3 1:200

CONSTRUCT

1:200



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ISSUED FOR: Issued for DA PROJECT TYPE: **SCALE**: 1:200

21 VEGA STREET REVESBY **DP**: 1528 DEVELOPMENT TYPE DATE: 2024

